

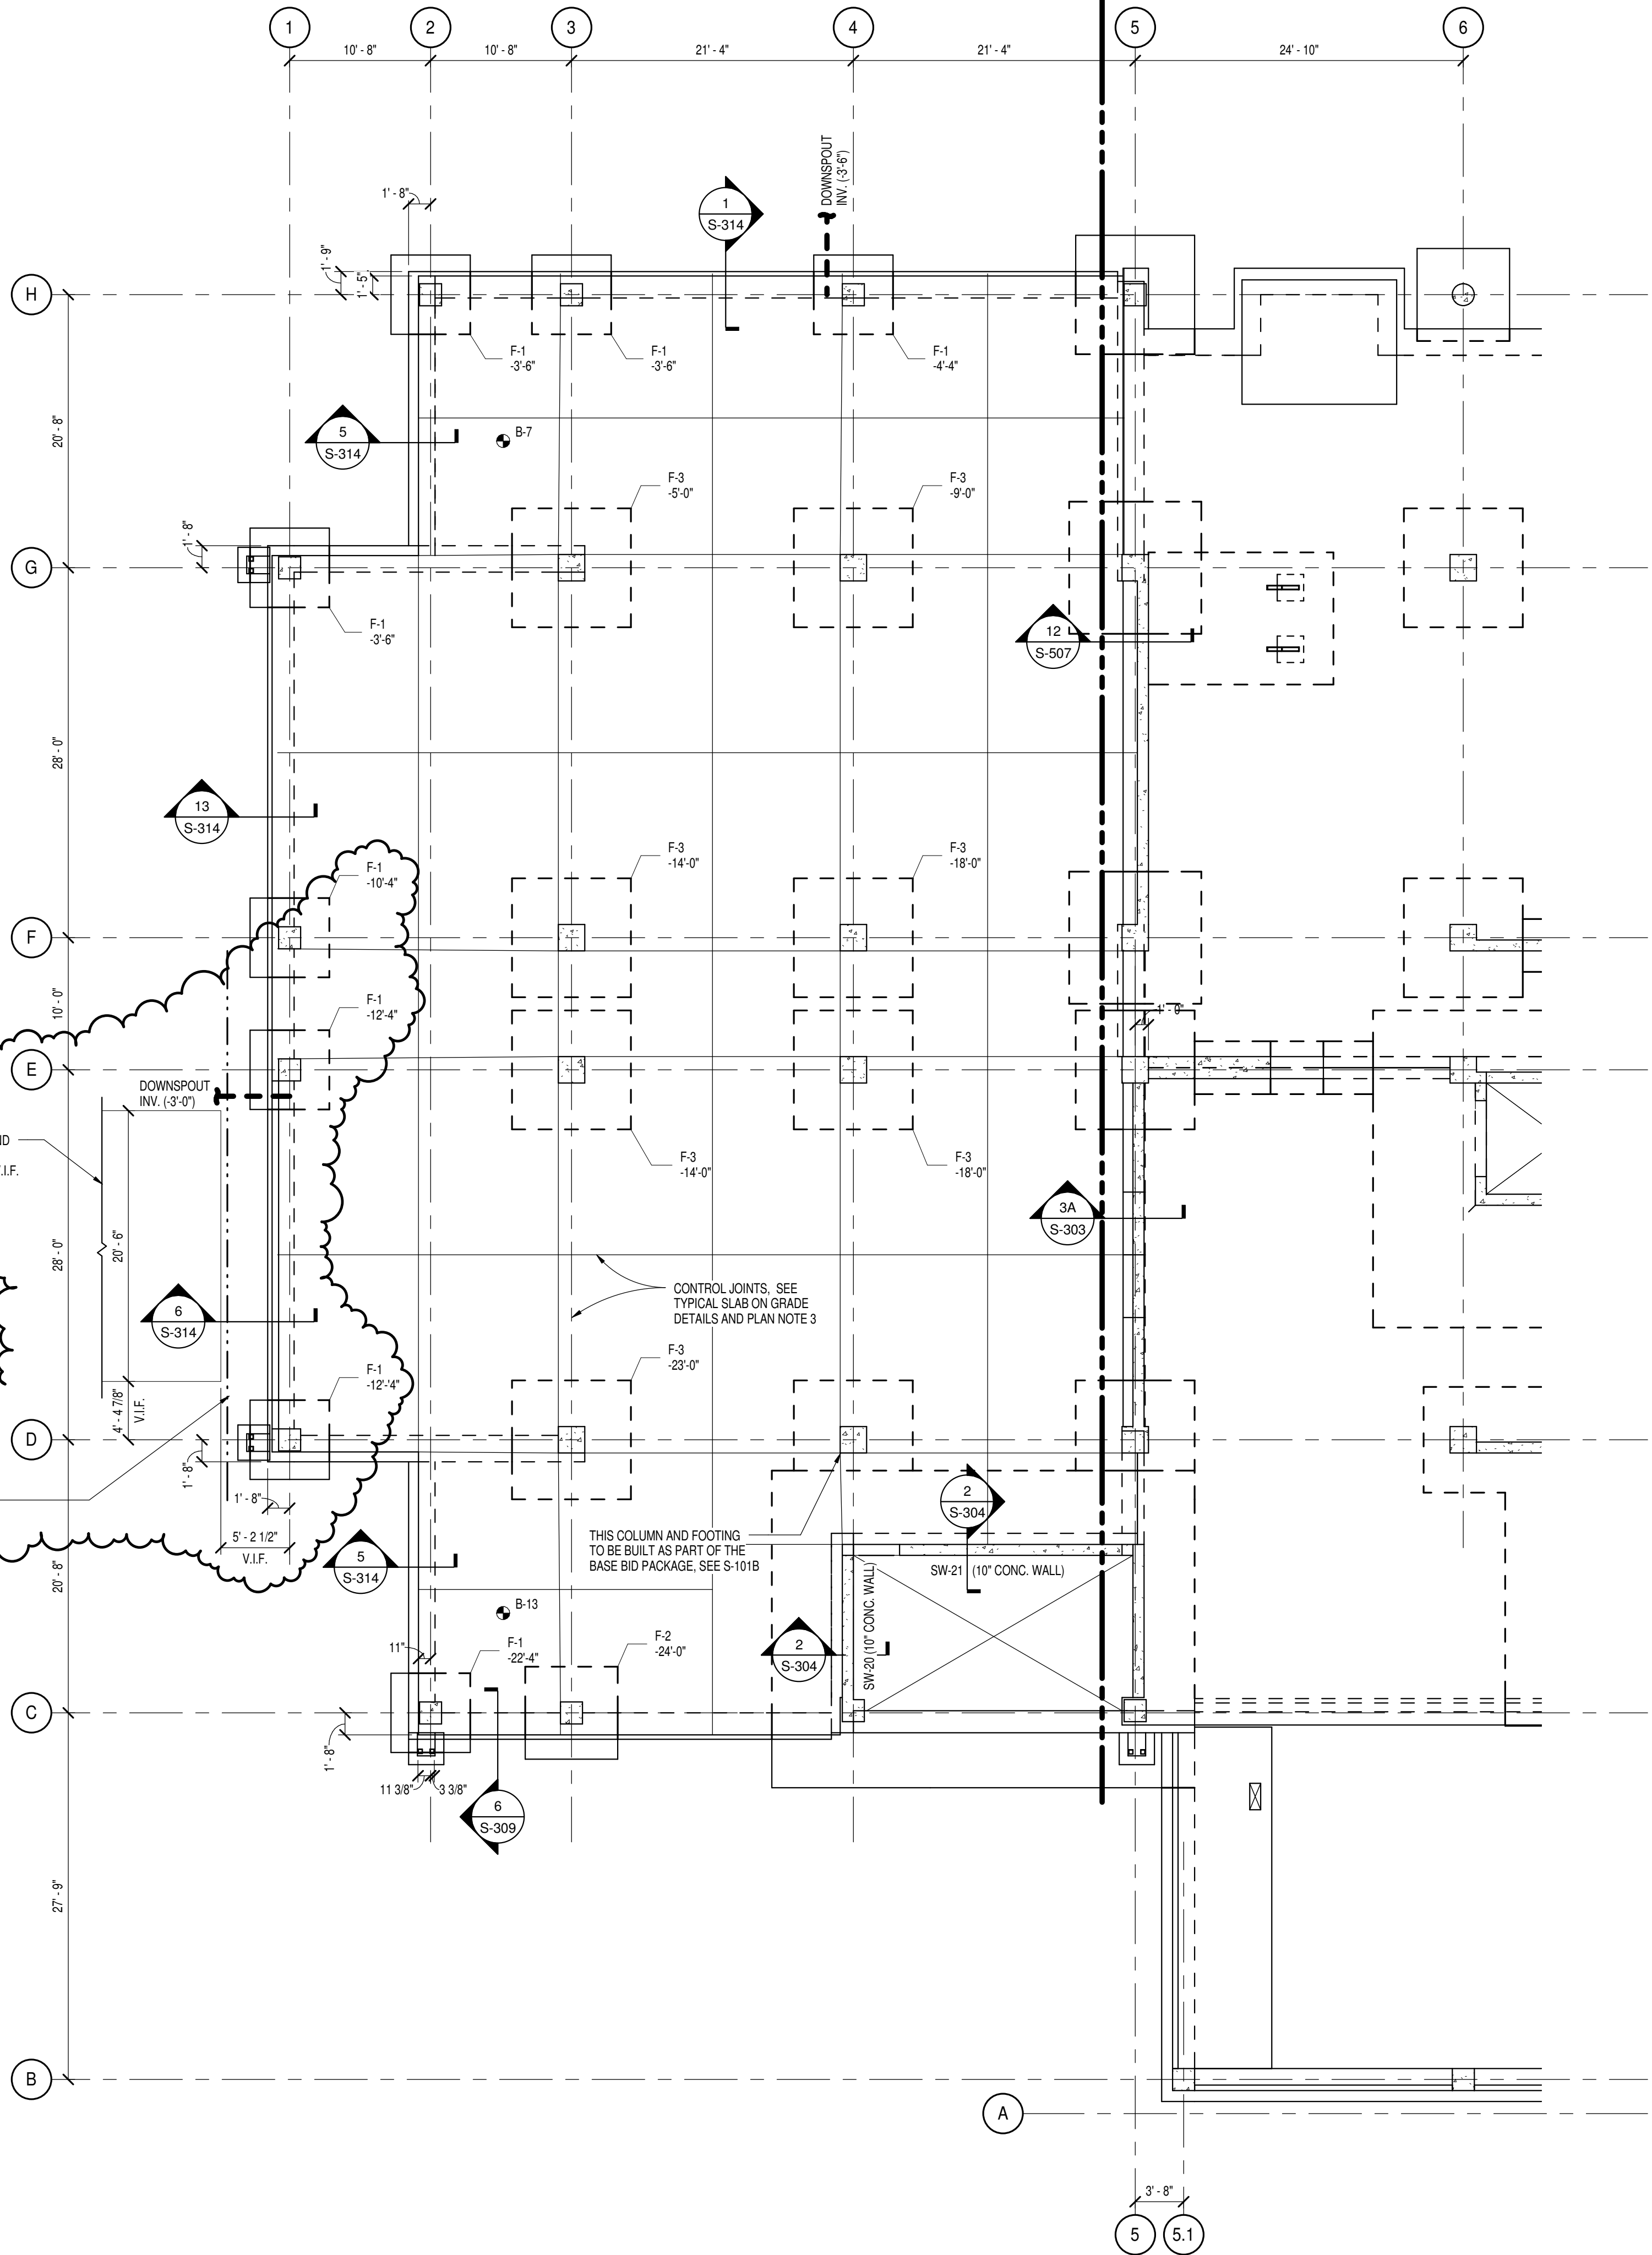


PLAN NOTES

1. TOP OF SLAB ON GRADE EL. = 0'-0".  
NOTE: EL. 0'-0" = ACTUAL DATUM EL. 86'-0".
2. SLAB ON GRADE SHALL BE A 6" THICK REINFORCED WITH 8WG W/ 18WG 3 WIR ON COMPACTED SUBGRADE.
3. CONTROL JOINTS (CJ) IN SLABS ON GRADE SHALL BE LOCATED ON COLUMN LINES AND BETWEEN COLUMN LINES WHERE NECESSARY IN BOTH DIRECTION SO AS NOT TO EXCEED JOINT SPACING OF 15 FEET. SEE PLAN FOR RECOMMENDED LAYOUT. LOCATE JOINTS AND PROVIDE REINFORCING AT RE-ENTRANT CORNERS PER 915.203.
4. EXTENT AND LOCATION OF FLOOR DEPRESSIONS SHALL BE COORDINATED WITH THE ARCHITECTURAL DRAWINGS.
5. SW-XX DENOTES CONCRETE SHEAR WALL. SEE DWG. S-204 AND S-205 FOR ELEVATIONS AND REINFORCING.
6. ALL COLUMNS, PIERS, AND FOOTINGS SHALL BE CENTERED ON GRID LINES UNLESS NOTED OTHERWISE.
7. SEE DWG. S-201 & S-202 FOR CONCRETE COLUMN SCHEDULE.
8. F-X DENOTES COLUMN FOOTING. SEE DWG. S-203 FOR SCHEDULE. ALSO SEE FOUNDATION SYMBOL LEGEND.
9. FS DENOTES STEP FOOTING. SEE S-301.
10. SEE ARCH DRAWINGS FOR ALL FOUNDATION WATERPROOFING AND INSULATION.
11. V.I.F. DENOTES VERIFY IN FIELD.

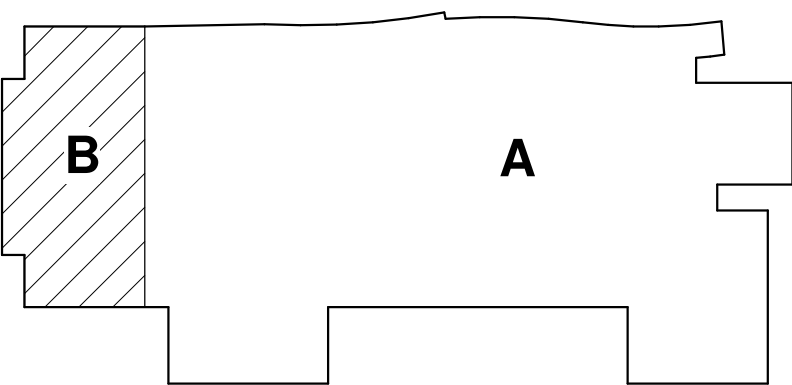

2 FOUNDATION AND FIRST FLOOR PLAN - ALTERNATE  
1/8" = 1'-0"

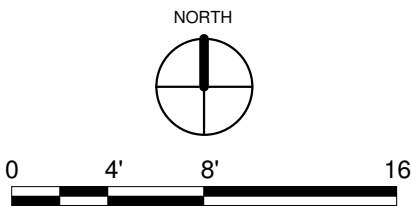

1		ADDENDUM #02		05/07/10	
JOB NO.		SHEET NO.		REVISION	
DATE		DWN.		APPD.	
JOB TITLE		DWS. TITLE		SHEET OF	
INTERDISCIPLINARY		FOUNDATION AND FIRST FLOOR PLAN - AREA B		1	
UNDER CONTRACT WITH		UNITED STATES DEPARTMENT OF ENERGY		PLANT ENGINEERING DIVISION	
UPTON, NEW YORK 11973		UPTON, NEW YORK 11973		UPTON, NEW YORK 11973	
SCALE		1/8" = 1'-0"		S-101B.1	
ECHO REK LEVEL		APPROVED BY		APPROVER	
FILENAME:		079872 S-101B.1		079872 S-101B.1	